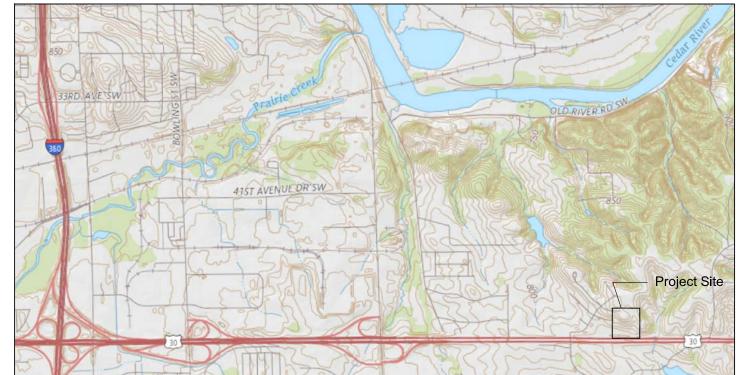
Cedar Rapids East Gateway Sign

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Vicinity Map



Sheet Index


Sheet No.	Sheet Title
L-0	TITLE SHEET
L-1	SITE PLAN
L - 2	ENLARGEMENT PLAN
L - 3	GRADING PLAN
L-4	SITE DETAILS
L - 5	SITE DETAILS

Cedar Rapids, Iowa

Project Name

CEDAR RAPIDS GATEWAY SIGN

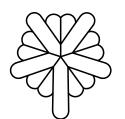Cedar Rapids,



City of Cedar Rapids,

Drawn By: Checked By:


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08/31/2018 Project No. 52-0626.00

CB, SK

TITLE SHEET

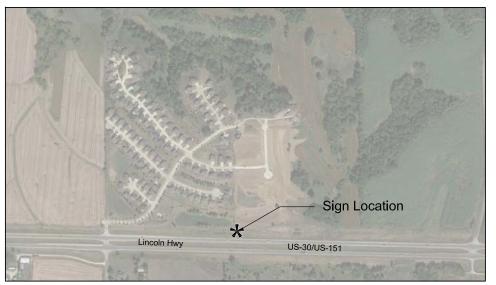Aerial










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Subconsultant

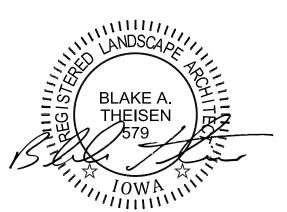

Ament Design 2025 S. Arlington Heights Road Suite 108 Arlington Heights, IL 60005 ph. 847-253-1515 IL Professional Design Firm #184.002495 CEDAR RAPIDS City of Five Seasons®

Plans Prepared For

CITY COUNCIL:

BRADLEY HART MAYOR. TYLER OLSON AT LARGE: ANN POE AT LARGE: AT LARGE: MARTIN HOEGER DISTRICT 2: SCOTT OVERLAND DISTRICT 3: DALE TODD SCOTT OLSON ASHLEY VANORNY DISTRICT 4: DISTRICT 5:

CITY OF CEDAR RAPIDS

THIS ENGINEERING DOCUMENT IS RECOMMENDED FOR FILING WITH THE CITY CLERK

PUBLIC WORKS DIRECTOR/CITY ENGINEER

DATE



GENERAL NOTES:

- A. SURVEY COMPLETED BY AMENT INC., BELOW GROUND INFORMATION WAS NOT SURVEYED.
- B. SURVEY IS IN IOWA STATE PLANE COORDINATE SYSTEM AND NAVD 88 ELEVATIONS.
- C. CONTRACTOR SHALL CONTACT IOWA ONE CALL BEFORE STARTING CONSTRUCTION TO VERIFY ALL BELOWGROUND UTILITIES.
- D. RESTORE AREAS DAMAGED DURING CONSTRUCTION.

ELECTRICAL NOTES

- A. THE CONTRACTOR IS RESPONSIBLE FOR THE DESIGN, DOCUMENTATION, AND INSTALLATION OF THE ENTIRE ELECTRICAL SYSTEM.
- B. ELECTRICAL EQUIPMENT SHALL BE MOUNTED TO AVOID IMPEDANCE OF OPERATION OF AND/OR ACCESS TO OTHER EQUIPMENT.
- C. ALL ELECTRICAL EQUIPMENT MOUNTED TO EQUIPMENT SUPPLIED BY OTHER CONTRACTORS SHALL BE APPROVED IN ADVANCE BY THE OTHER CONTRACTOR.
- D. ALL WELDING SHALL BE ACCORDING TO THE AMERICAN WELDING SOCIETY STANDINGS.

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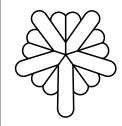
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Revision Date

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CEDAR RAPIDS GATEWAY SIGN

Cedar Rapids, IA



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Sheet Title

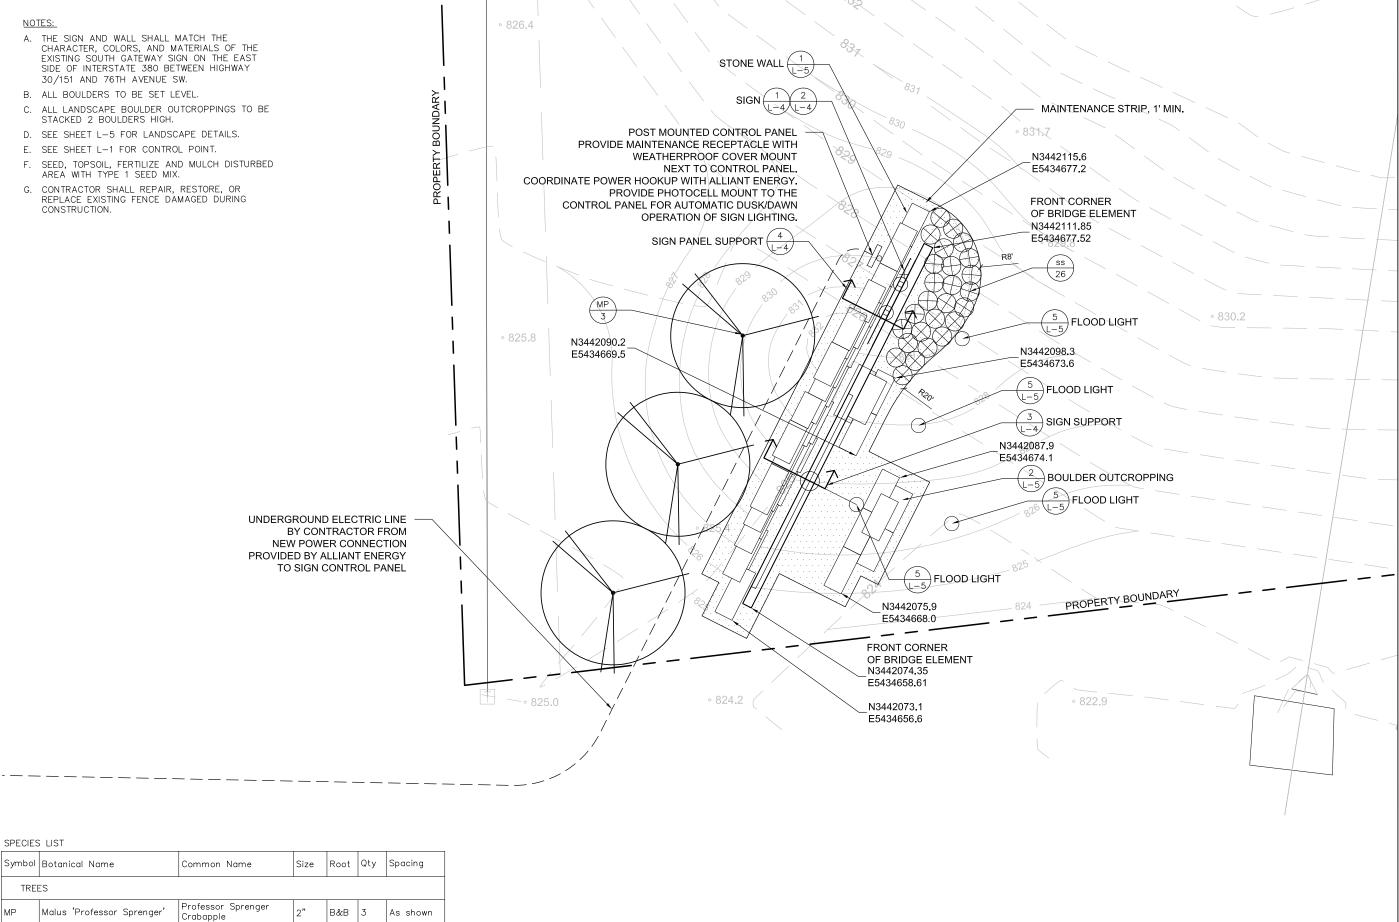
SITE PLAN





neet Number

L-1



GRASSES

Schizachyrium scoparium

Little Bluestem

Gal. Cont. 26 24" o.c.

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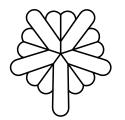
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Project Name

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Sheet Title

ENLARGEMENT PLAN N





NUIES:

1. ALL IMPORTED GRANULAR FILL FOR USE UNDER STRUCTURES SHALL BE FREE OF ANY ORGANIC MATERIAL OR LARGE STONES. OTHER FILL IMPORTED FOR AREAS NOT UNDER STRUCTURES SHALL BE REASONABLY FREE OF DEBRIS, ROOTS AND STONES LARGER THAN 6".

GRADING GENERAL NOTES:

- 1. CONTOURS AND SPOT GRADES SHOWN IN PLANS MAY BE MODIFIED TO FIT
- EXISTING CONDITIONS AFTER DISCUSSION WITH THE ENGINEER OR OWNER.

 2. ALL EXCESS MATERIAL SHALL BE STOCKPILED AT LOCATIONS APPROVED BY THE OWNER'S REPRESENTATIVE PRIOR TO PLACEMENT OF ANY
- BY THE OWNER'S REPRESENTATIVE PRIOR TO PLACEMENT OF ANY MATERIAL. STOCKPILES SHALL BE ENCLOSED WITH SILT FENCE UNTIL TEMPORARY OR PERMANENT VEGETATIVE COVER IS ESTABLISHED.

 3. THE REMOVAL OF VEGETATIVE COVER AND EXPOSURE OF THE BARE GROUND MUST BE RESTRICTED TO THE MINIMUM AMOUNT NECESSARY FOR CONSTRUCTION. AREAS WHERE SOIL IS EXPOSED MUST BE PROTECTED FROM EROSION BY SEEDING AND MULCHING, SODDING, DIVERSION OF SURFACE RUNOFF, INSTALLATION OF STRAW BALES OR SILT SCREENS, CONSTRUCTION OF SETTLING BASINS, OR SIMILAR METHODS AS SOON AS POSSIBLE AFTER REMOVAL OF THE ORIGINAL GROUND COVER.

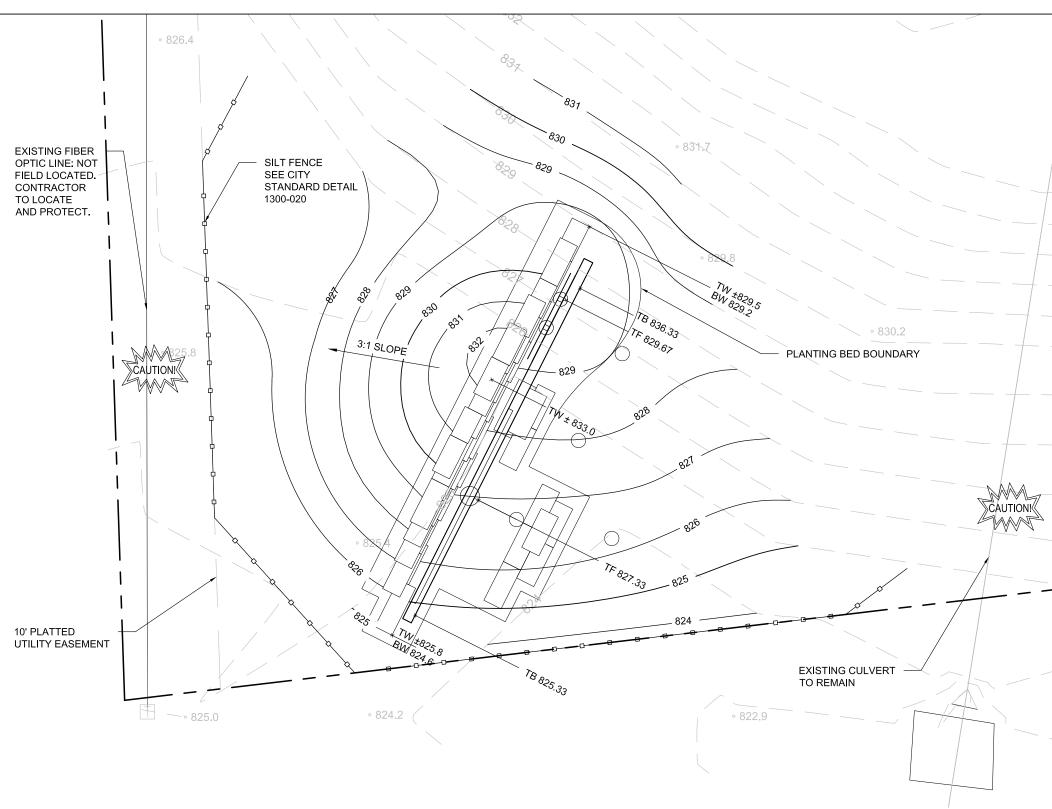
 4. SEE EROSION CONTROL NOTES ON SHEET L—1.

 5. ALL UNDERGROUND UTILITIES HAVE BEEN SHOWN TO A REASONABLE DEGREE OF ACCURACY. IT SHALL BE THE CONTRACTORS RESPONSIBILITY TO VERIFY THEIR EXACT LOCATION AND DEPTH.
- TO VERIFY THEIR EXACT LOCATION AND DEPTH.

EROSION NOTES:

- A. COMPLETE WORK IN ACCORDANCE WITH CITY OF CEDAR RAPIDS METROPOLITAN AREA STANDARD SPECIFICATIONS FOR PUBLIC IMPROVEMENT
 - http://cms.revize.com/revize/cedarrapids/local_government/
 departments_g_-_v/public_works/public_improvement_standards.php#revize
 _document_center_rz1611
- B. THE CONTRACTOR SHALL MINIMIZE THE AMOUNT OF DISTURBED AREA.
- C. PLANS SHOW SUGGESTED LOCATIONS FOR INSTALLATION OF EROSION CONTROL ITEMS. FINAL LOCATIONS SHALL BE DETERMINED IN THE FIELD BY THE CONTRACTOR AND APPROVED BY THE ENGINEER. EROSION CONTROL ITEMS SHALL BE IN PLACE PRIOR TO CONTROL ITEMS SHALL BE IN PLACE PRIOR TO DEMOLITION/CONSTRUCTION. EROSION CONTROL ITEMS SHALL BE MAINTAINED UNTIL SUCH TIME THAT THE ENGINEER DEEMS THE DEVICES NO LONGER NECESSARY. CONTRACTOR SHALL ENSURE CONTROL DEVICES ARE OPERATING EFFECTIVELY ON NO LESS THAN A WEEKLY BASIS. DURING INCLEMENT WEATHER THE CONTRACTOR SHALL EXAMINE DEVICES
- D. SOIL DISTURBANCE SHALL BE CONDUCTED IN SUCH A MANNER AS TO MINIMIZE EROSION. SOIL STABILIZATION MEASURES SHALL CONSIDER THE TIME OF YEAR, SITE CONDITIONS AND THE USE OF TEMPORARY OR PERMANENT MEASURES. ALL DISTURBED AREAS OF LAWN SHALL BE PATCHED WITH SEED FERTILIZER AND MULCH/MAT. http://cms.revize.com/revize/cedarrapids/Public%20Works/Standards— Specs-DesignDetails/Ch%207%20Erosion%20Control.pdf
- E. ALL DISTURBED AREAS SHALL BE STABILIZED PER THE CITY'S SPECIFICATIONS IF THERE IS A DELAY OF MORE THAN 14 CALENDAR DAYS BETWEEN INITIAL GRADING AND FINAL TOPSOIL AND SEEDING.
- F. ALL DISTURBED AREAS SHALL BE STABILIZED WITH TEMPORARY OR PERMANENT MEASURES WITHIN 14 CALENDAR DAYS OF THE END OF ACTIVE HYDROLOGIC DISTURBANCE, OR RE-DISTURBANCE. THE CONTRACTOR SHALL USE BONDED FIBER MESH SOIL STABILIZER ON ALL SEEDED SURFACES WITH SLOPES GREATER THAN 9%.
- G. ALL TEMPORARY EROSION AND SEDIMENT CONTROL MEASURES SHALL BE REMOVED WITHIN 30 DAYS AFTER FINAL SITE STABILIZATION IS ACHIEVED OR AFTER THE TEMPORARY MEASURES ARE NO LONGER NEEDED.
- ON AFTER THE TEMPORANT MEASURES ARE NO LONGER NEEDED.

 A STABILIZED CONSTRUCTION ENTRANCE PER THE CITY STANDARD DETAIL 1300-60 WILL BE REQUIRED FOR THIS PROJECT. THE CONTRACTOR SHALL SECURE CITY APPROVAL AND APPROVAL FROM OTHER GOVERNING AGENCIES IF REQUIRED FOR CONSTRUCTION ENTRANCE LOCATION. THE EROSION CONTROL MEASURES INDICATED ON THE PLANS ARE THE MINIMUM REQUIREMENTS. ADDITIONAL MEASURES MAY BE REQUIRED AS DIRECTED BY THE ENGINEER OR GOVERNING AGENCY.



LEGEND

- TW TOP OF WALL
- TS TOP OF STONE
- TF TOP OF FOUNDATION TB TOP OF BRIDGE
- BW FINISH GRADE AT BOTTOM

OF WALL

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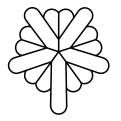
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Revision

Project Name

CEDAR RAPIDS GATEWAY SIGN

Cedar Rapids, IΑ



City of Cedar Rapids, lowa

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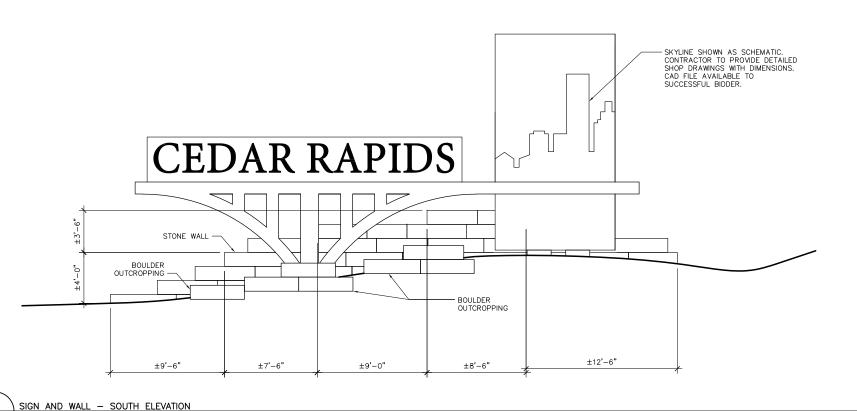
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BM


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GRADING PLAN






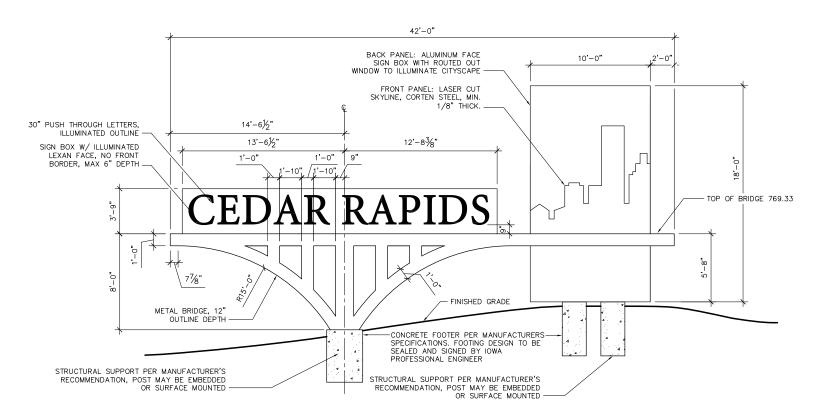SCALE 1/8" = 1'-0"




SIGN - SECTION SCALE 1/8" = 1'-0"

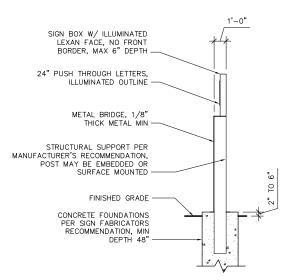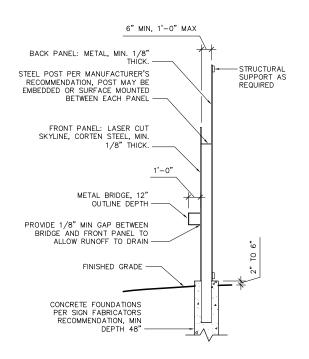- IOIE:
 FOUNDATION DESIGN IS THE
 RESPONSIBILITY OF THE SIGN
 MANUFACTURER.
 PROVIDE SHOP DRAWINGS FOR SIGN.
 MAINTENANCE STRIP TO INCLUDE
 WEED BARRIER UNLESS SET ON
 DENSE GRADED BASE.









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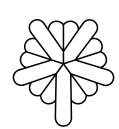
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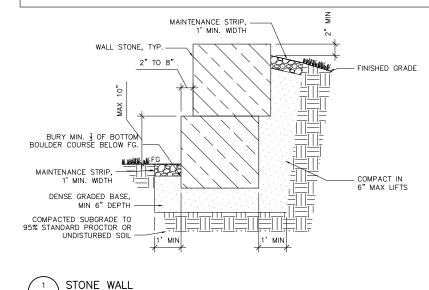
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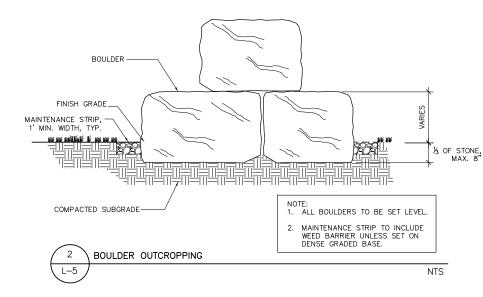
SITE DETAILS


BLOCK STONE WALL NOTES

L-5

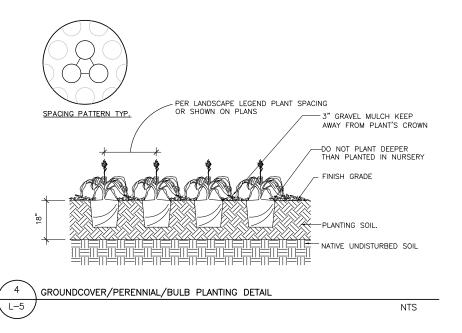
- 1. COURSING HEIGHTS TO STAY CONSISTENT WITHIN COURSE, BUT MAY VARY FROM 12"-16" BETWEEN COURSES.
- 2. PLACE LARGEST BOULDERS ON BOTTOM COURSE, BURY AS INDICATED ON DETAILS.
- 3. STONES SHALL BE FIT TIGHT WITH MAXIMUM 2" GAP BETWEEN 75% OF THE STONES.
- 4. STONES SHALL BE SET LEVEL AND FIRM ON COMPACTED BASE OVERLAPPING STONE BELOW AS INDICATED.
- 5. MAINTENANCE STRIP TO INCLUDE WEED BARRIER UNLESS SET ON DENSE GRADED BASE








NTS

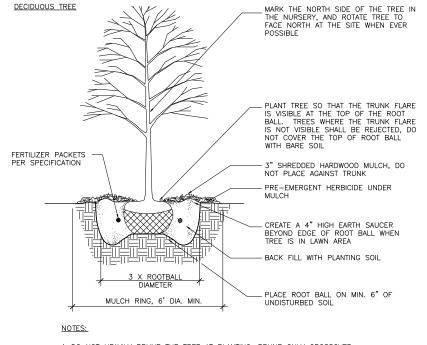

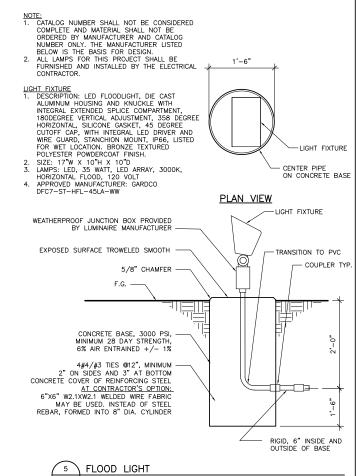- 1. DO NOT HEAVILY PRUNE THE TREE AT PLANTING, PRUNE ONLY CROSSOVER LIMBS, CO-DOMINANT LEADERS, AND BROKEN OR DEAD BRANCHES. SOME INTERIOR TWIGS AND LATERAL BRANCHES MAY BE PRUNED; INITERIOR IMIGS AND LAIERAL BRANCHES MAY BE PRONED;
 HOWEVER, DO NOT REMOVE THE TERMINAL BUDS OF BRANCHES THAT EXTEND TO
 THE EDGE OF THE CROWN
 2. STAKE TREES ONLY UPON THE APPROVAL OF THE LANDSCAPE ARCHITECT
 3. WRAP TREE TRUNKS ONLY UPON THE APPROVAL OF THE LANDSCAPE ARCHITECT
 4. REMOVE ALL TWINE, ROPE, WIRE AND BURLAP FROM TOP AND SIDES OF ROOT BALL.







Professional Seal


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SITE DETAILS
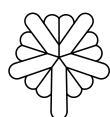
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